

- GENERAL NOTES:
1. EROSION CONTROL FACILITIES MUST BE FIELD INSTALLED PRIOR TO ANY CONSTRUCTION ACTIVITY AND MAINTAINED UNTIL THE AREA IS STABILIZED AND NO FURTHER SEDIMENTATION IS TAKING PLACE.
 2. ON TEMPORARY ROADWAYS AND PARKING AREAS, A 150MM TO 200MM COURSE OF CRUSHED GRANULAR AGGREGATES SHALL BE APPLIED TO THE SITE AFTER GRADING.
 3. EROSION CONTROL FACILITIES MUST BE FIELD INSPECTED EVERY 7 DAYS AND FOLLOWING HEAVY RAINSTORMS OR SNOWMELT EVENTS. ALL DISTURBED AREAS OF THE SITE, MATERIAL STORAGE AREAS, ENTRANCE AND EXIT ROADS, AND ALL EROSION AND SEDIMENTATION CONTROL MUST BE INSPECTED. INSPECTION IS THE RESPONSIBILITY OF THE DEVELOPER/OWNER OR HIS DESIGNATE, WHICH COULD BE THE CONTRACTOR AND/OR CONSULTANT.
 4. AT THE COMPLETION OF THE WORK, ALL ACCUMULATED SEDIMENT, DEBRIS AND WORK RELATED MATERIAL SHOULD BE REMOVED AND PROPERLY DISPOSED OF OFF SITE AND IN A MANNER WHICH PREVENTS THE SAME FROM ENTRY INTO ANY TYPE OF WATER COURSE.
 5. STOCKPILES SHALL BE LOCATED AWAY FROM WATERCOURSES AND STABILIZED AGAINST EROSION OR SEDIMENTATION. ALL DISTURBED AREAS ARE TO BE SEEDED WITHIN 30 DAYS IF NO FURTHER GRADING ACTIVITIES ARE TO OCCUR.




PROJECT AREA KEY PLAN NTS

METRIC METRIC UNITS
DISTANCES SHOWN ON THIS PLAN ARE IN METRES AND CAN BE CONVERTED TO FEET BY DIVIDING BY 0.3048

LEGEND

| | |
|--|---------------------------------------|
| | ORIGINAL GROUND |
| | FINISHED GRADE |
| | BOTTOM OF SODDED SWALE/BACK OF CURB |
| | MIN. FINISHED GRADE AT HOUSE LOCATION |
| | PROP. EXT. WATERMAIN - GATE VALVE |
| | PROP. EXT. WATERMAIN - FIRE HYDRANT |
| | PROP. EXT. STORM MANHOLE |
| | PROP. EXT. SANITARY MANHOLE |
| | PROP. EXT. STORM CATCH BASIN |
| | PROP. CLEANOUT/WATER SHUTOFF VALVE |
| | PROP. EXT. TOP OF SWALE |
| | PROP. EXT. TOP OF BANK |
| | PROP. EXT. BOTTOM OF BANK |
| | PROP. EXT. SANITARY SEWER PIPE |
| | PROP. EXT. STORM SEWER PIPE |
| | PROP. EXT. STORM SEWER CULVERT |
| | PROP. EXT. WATERMAIN |
| | PROP. EXT. OVERHEAD HYDRO LINES |
| | PROP. EXT. EDGE OF ASPHALT & FEATURES |
| | PROP. EXT. CHAINLINK FENCE |
| | PROP. CUT/FILL TO EXISTING GROUND |

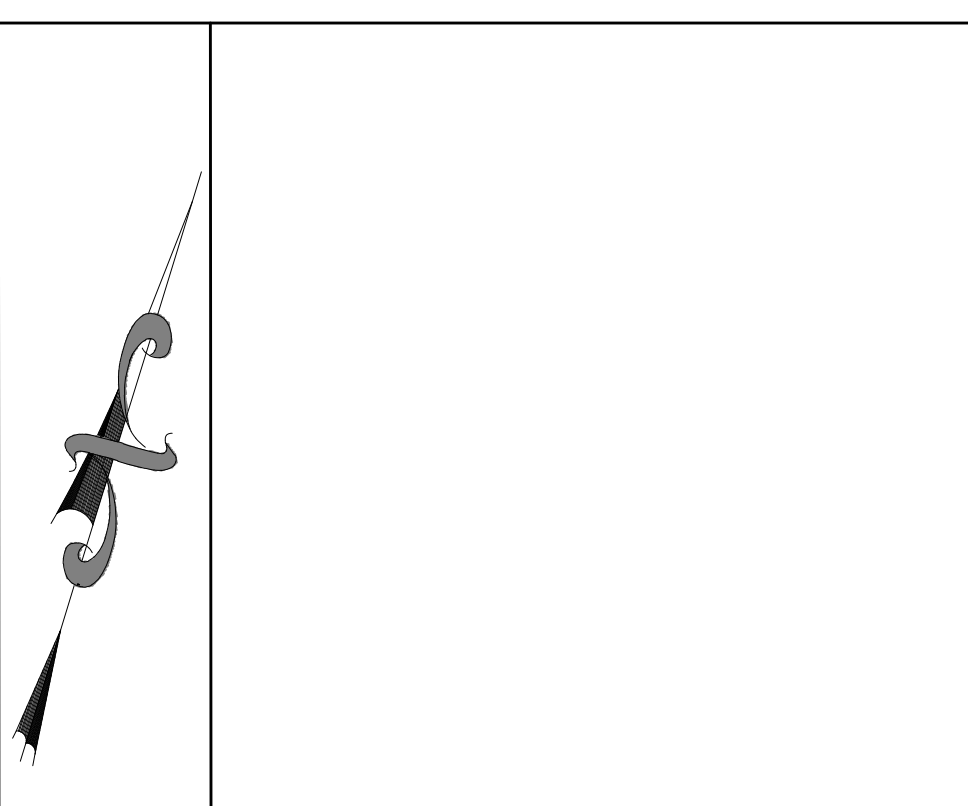

DATE OF ISSUE: ---

| | | | |
|----------------|----------------------|----------------|----|
| Jeffrey Miller | ISSUED FOR RE ZONING | May 19, 2020 | 1 |
| Jeffrey Miller | PRELIMINARY | April 21, 2020 | 0 |
| APPD BY | DETAILS | DATE | No |


REVISIONS
DESCON CONSTRUCTION Ltd.
NOAH PROJECT

ONTARIO STREET
VILLAGE OF SUNDRIDGE

EROSION CONTROL PLAN


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| | | | |
|------------------|-----------------------|------------|----------|
| DRAWN BY: | Brian Cherry | DATE: | MAY 2020 |
| DESIGNED BY: | Jeffrey Miller, P.Eng | SCALE: | 1:300 |
| CHECKED BY: | Jeffrey Miller, P.Eng | | |
| (M&U) PROJECT No | 6513 | DRAWING No | C03 |
| | | REV. | 1 |

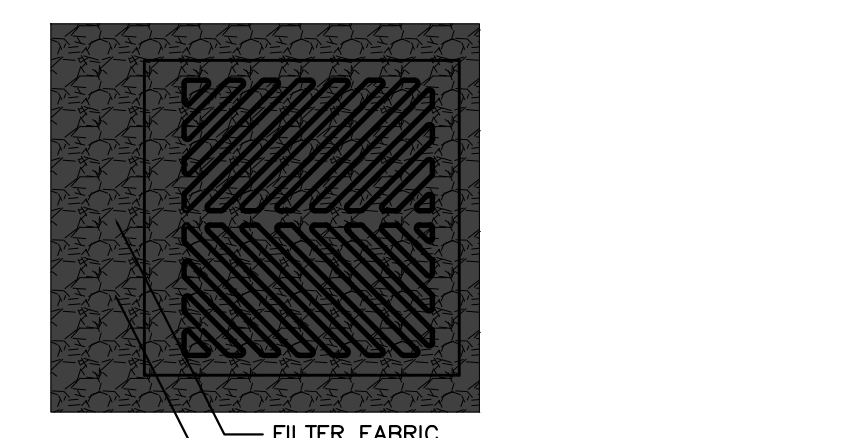

CONTRACTOR TO PLACE 50mm CLEAR STONES ON FILTER FABRIC TO HOLD IN PLACE


CB PLAN

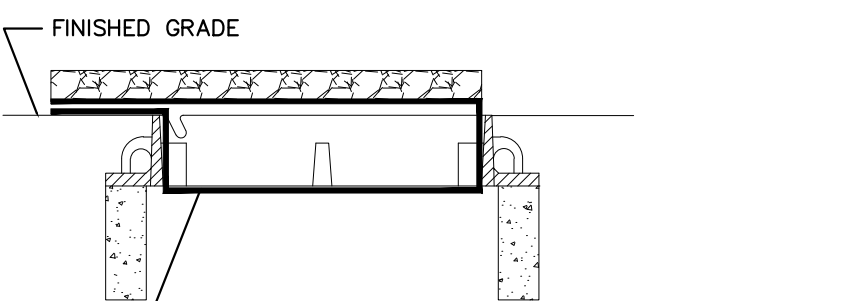


CONTRACTOR TO ENSURE SEDIMENT DOES NOT ENTER CATCH BASIN DURING CLEANING/REPLACEMENT AND REMOVAL

CB SECTION


04 DETAIL - FILTER FABRIC UNDER CATCH BASIN LID
C-4 SCALE: NTS

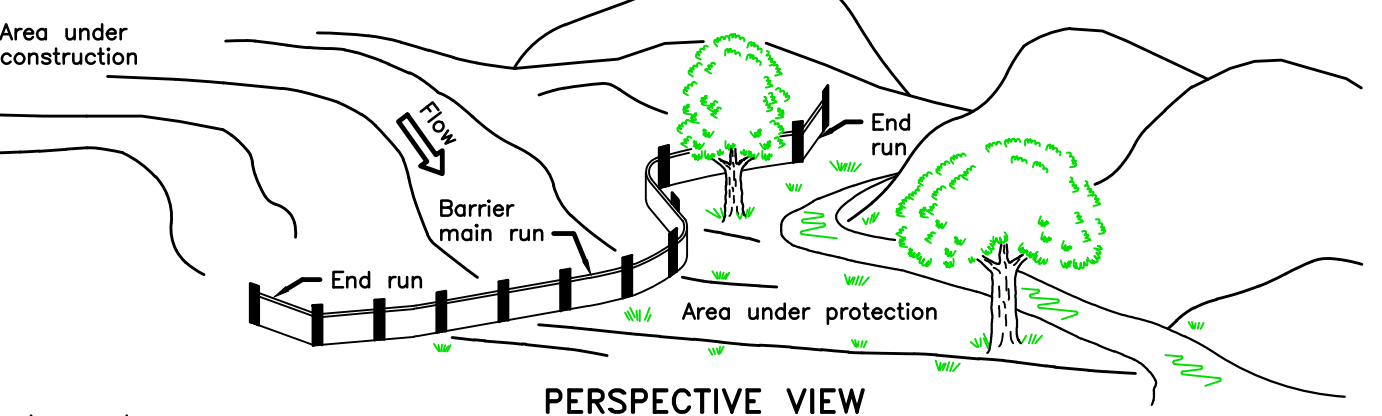

PERSPECTIVE VIEW

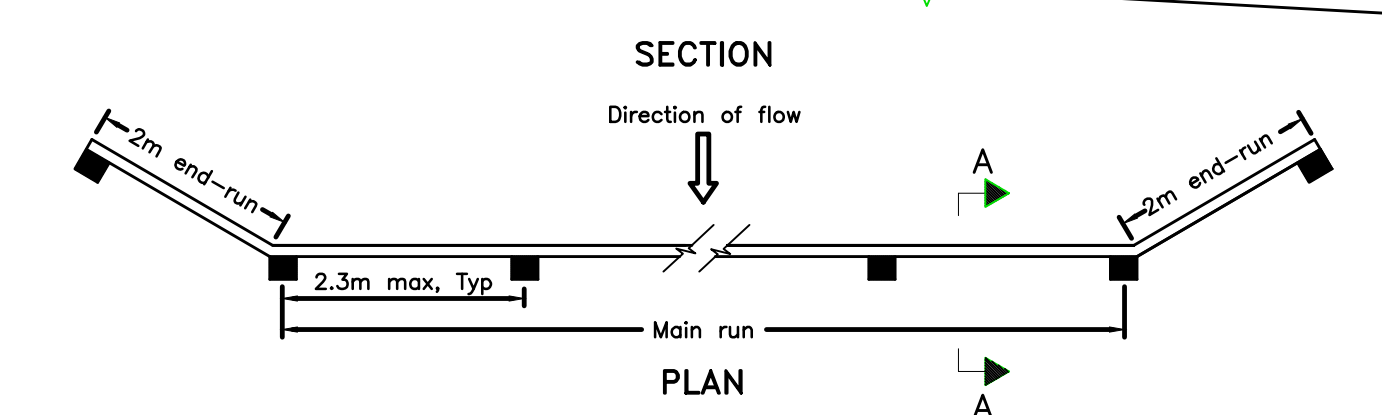

SECTION

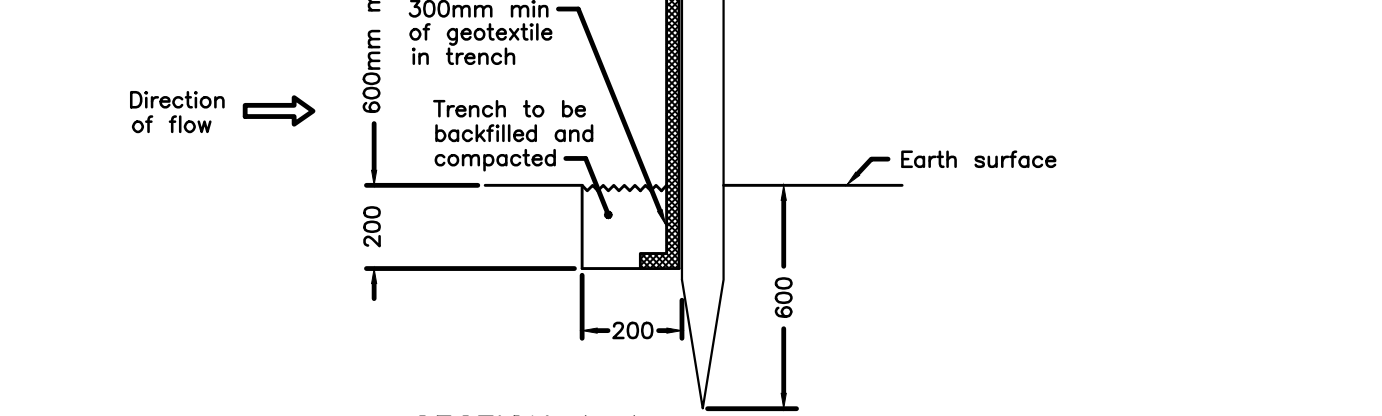

SECTION A-A

NOTE:
A All dimensions are in millimetres unless otherwise shown.